8 HADDON CRESCENT, REVESBY PROPOSED DUAL OCCUPANCY

STORMWATER CONCEPT PLANS



LOCALITY PLAN

DRAWING INDEX							
Drawing No.	DESCRIPTION						
000	COVER SHEET PLAN						
101	STORMWATER CONCEPT PLAN GROUND LEVEL						
102	CATCHMENT PLAN						
103	SEDIMENT & EROSION CONTROL PLAN & DETAILS						
104	MAINTENANCE SCHEDULE & MISCELLANEOUS DETAILS SHEET						

NOT FOR CONSTRUCTION

						NLAS Designs
Α	ISSUE FOR DEVELOPMENT APPLICATION	08/07/2024	SFK	EH	ОС	
Issue	Description	Date	Designed	Engineer	Checked	
1 0	1cm at full,size	1 1 1			20cm	İ

Canterbury-Bankstown Council




CIVIL & STORMWATER ENGINEERING SERVICES PTY LTD ABN: 27 644 422 506

Shop 1, 143-147 Parramatta Road, Concord, NSW STORMWATER CONCEPT PLAN P:(02) 8397 6500

8 HADDON CRESCENT, REVESBY PROPOSED DUAL OCCUPANCY

Drawing Title
COVER SHEET PLAN

Dwg. No. 240071

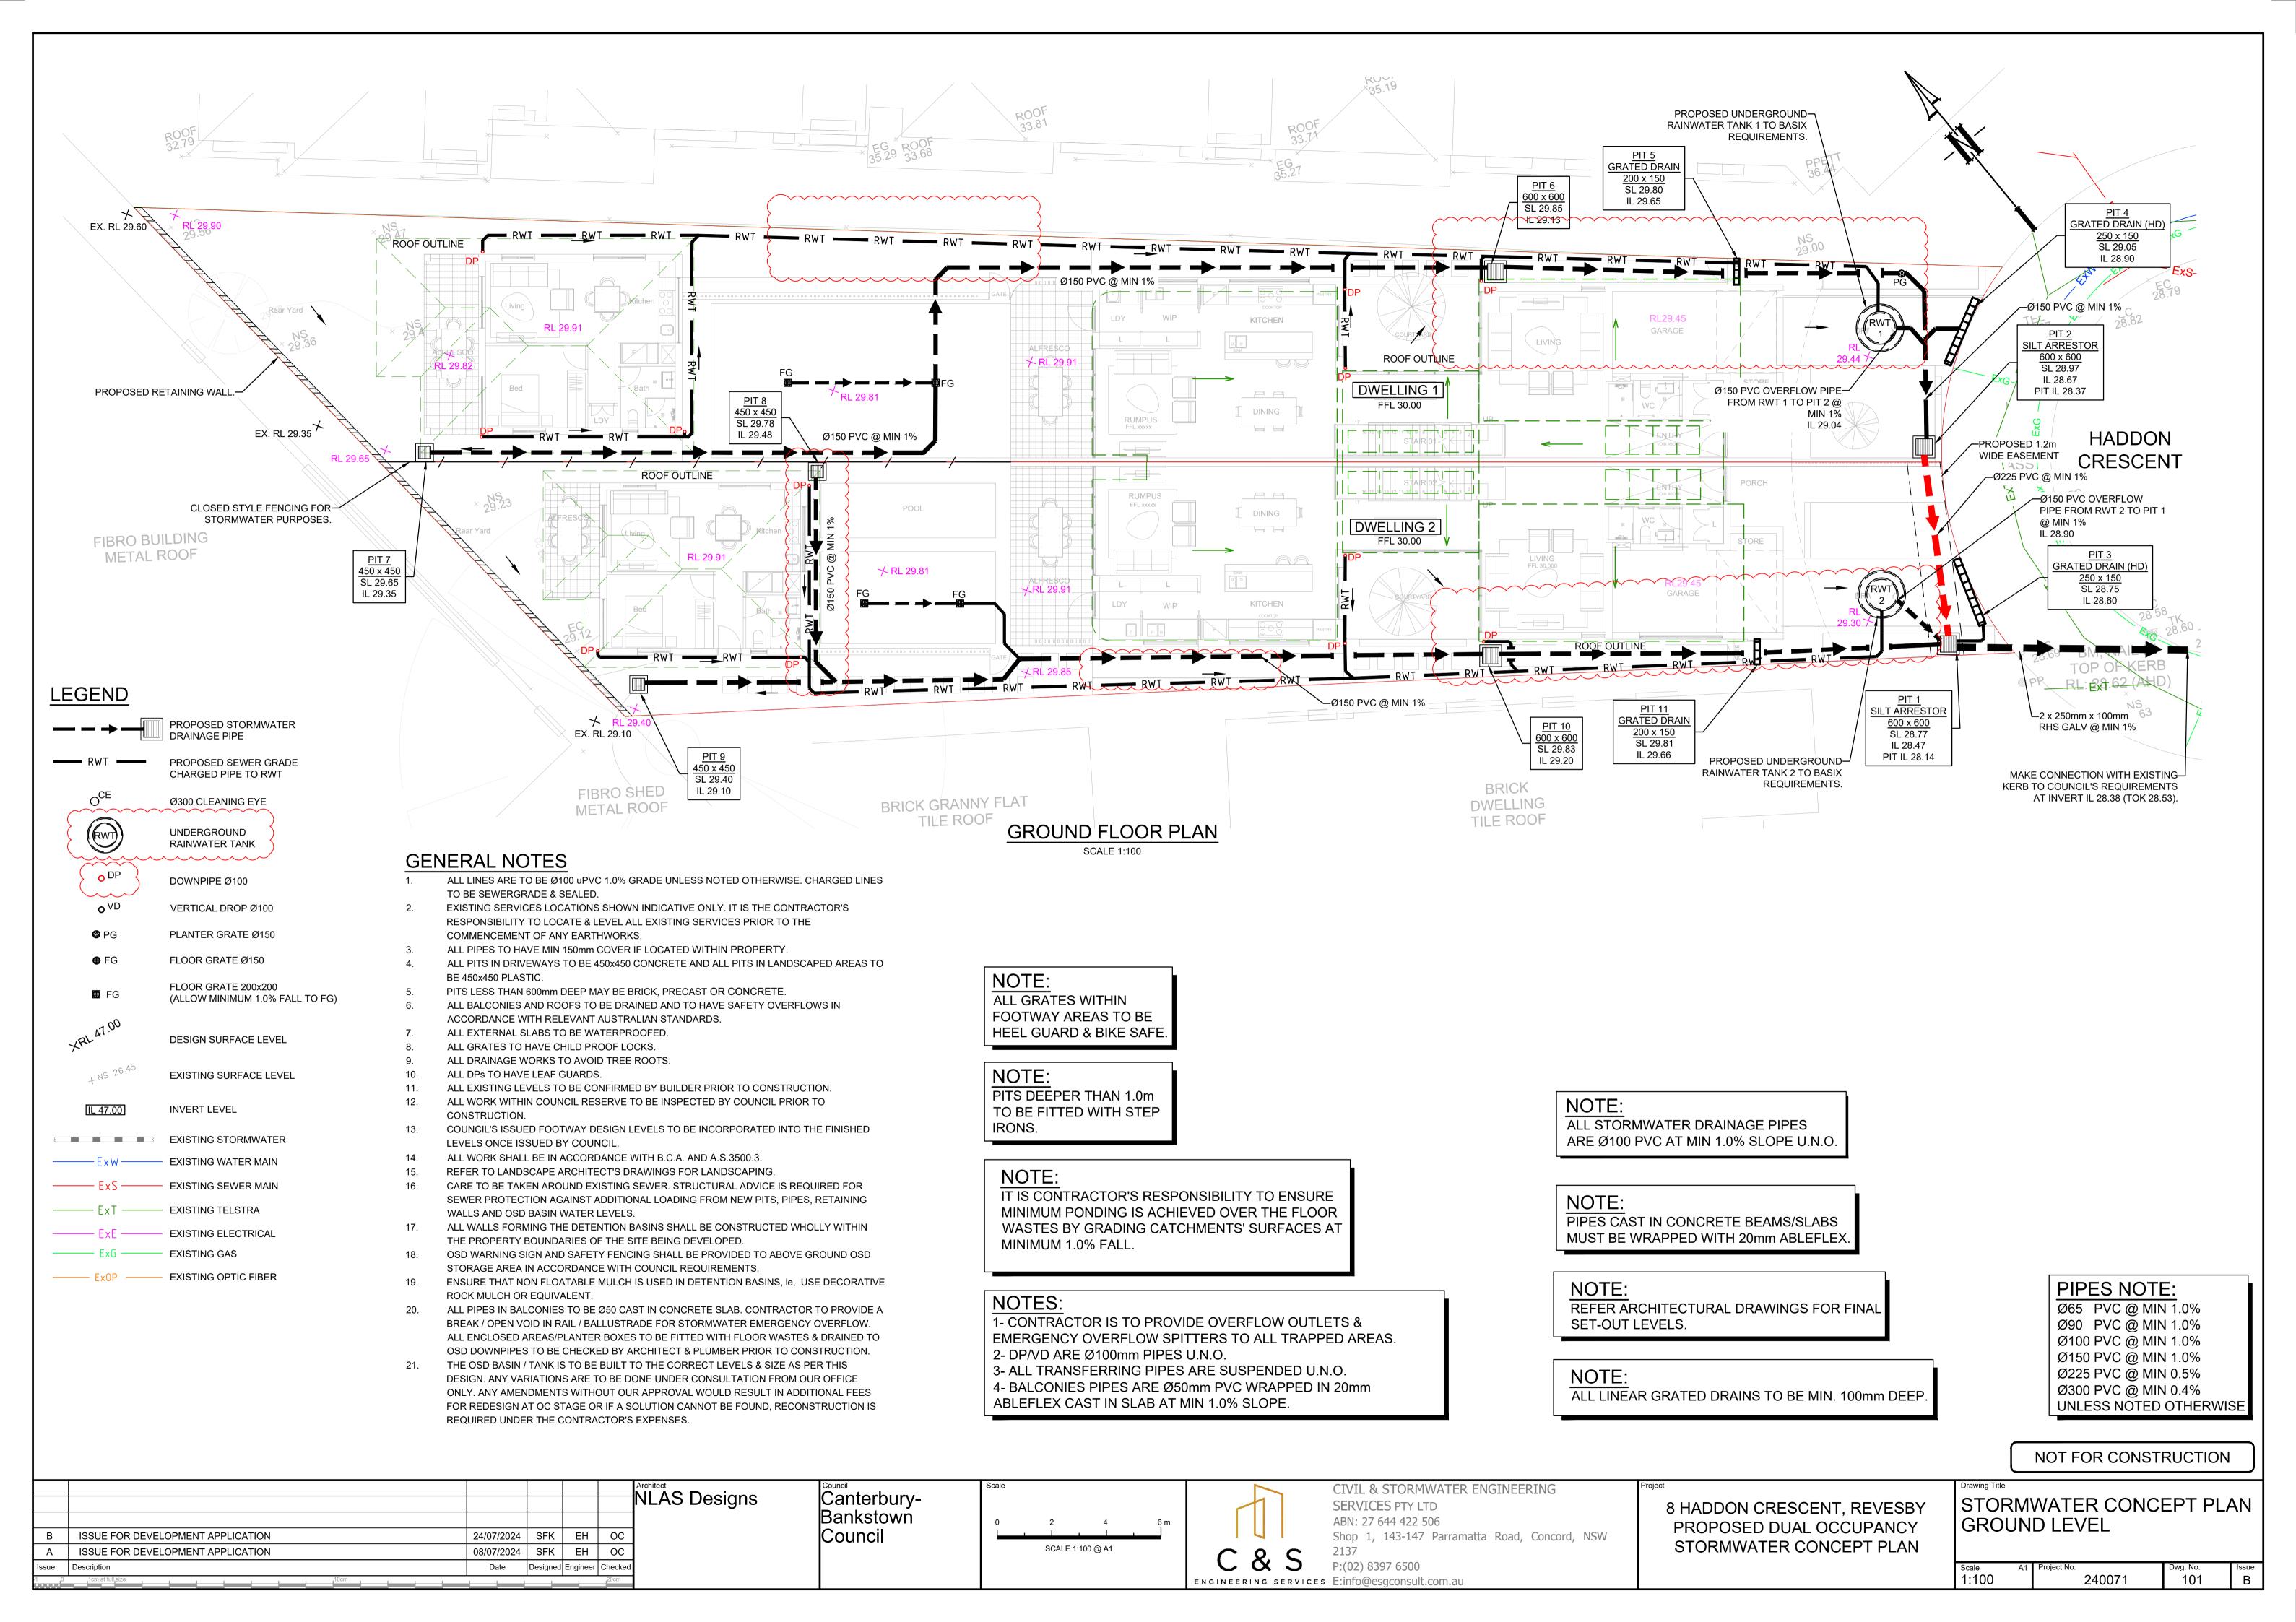


DWELLING 1 HADDON CRESCENT CATCHMENT LEGEND DWELLING 1 IMPERVIOUS AREA = 315.9m² PERVIOUS AREA = 194.5m² TOTAL AREA SITE AREA = 510.4m² (38.10% OF THE SITE PERVIOUS) CATCHMENT LEGEND DWELLING 2 IMPERVIOUS AREA = 303.14m² PERVIOUS AREA = 141.26m² TOTAL AREA SITE AREA = 444.4m² (31.78% OF THE SITE PERVIOUS) CATCHMENT PLAN

NOTE:


AS PER CANTERBURY-BANKSTOWN COUNCIL'S DCP PART B5.5.1, OSD IN NOT REQUIRED WHEN THE PROPOSED IMPERVOUS AREA IS LESS THAN 70% OF THE SITE. IN THIS CASE THE DRAINAGE SYSTEM CAN BE DESIGNED WITHOUT OSD.

NOT FOR CONSTRUCTION


Δ	ISSUE FOR DEVELOPMENT APPLICATION 08/07/2024 SFK EH OC	-	Canterbury- Bankstown Council	Scale 0 2 4 6 m L J J J J J SCALE 1:100 @ A1	CIVIL & STORMWATER ENGINEERING SERVICES PTY LTD ABN: 27 644 422 506 Shop 1, 143-147 Parramatta Road, Concord, NSW 2137	8 HADDON CRESCENT, REVESBY PROPOSED DUAL OCCUPANCY STORMWATER CONCEPT PLAN	CATCHMENT PLAN
Issue	Description Date Designed Engineer Checked	1			C & S P:(02) 8397 6500		Scale A1 Project No. Dwg. No. Issue
1 0	1cm at full, size10cm20cm				ENGINEERING SERVICES E:info@esgconsult.com.au		As Shown 240071 102 A

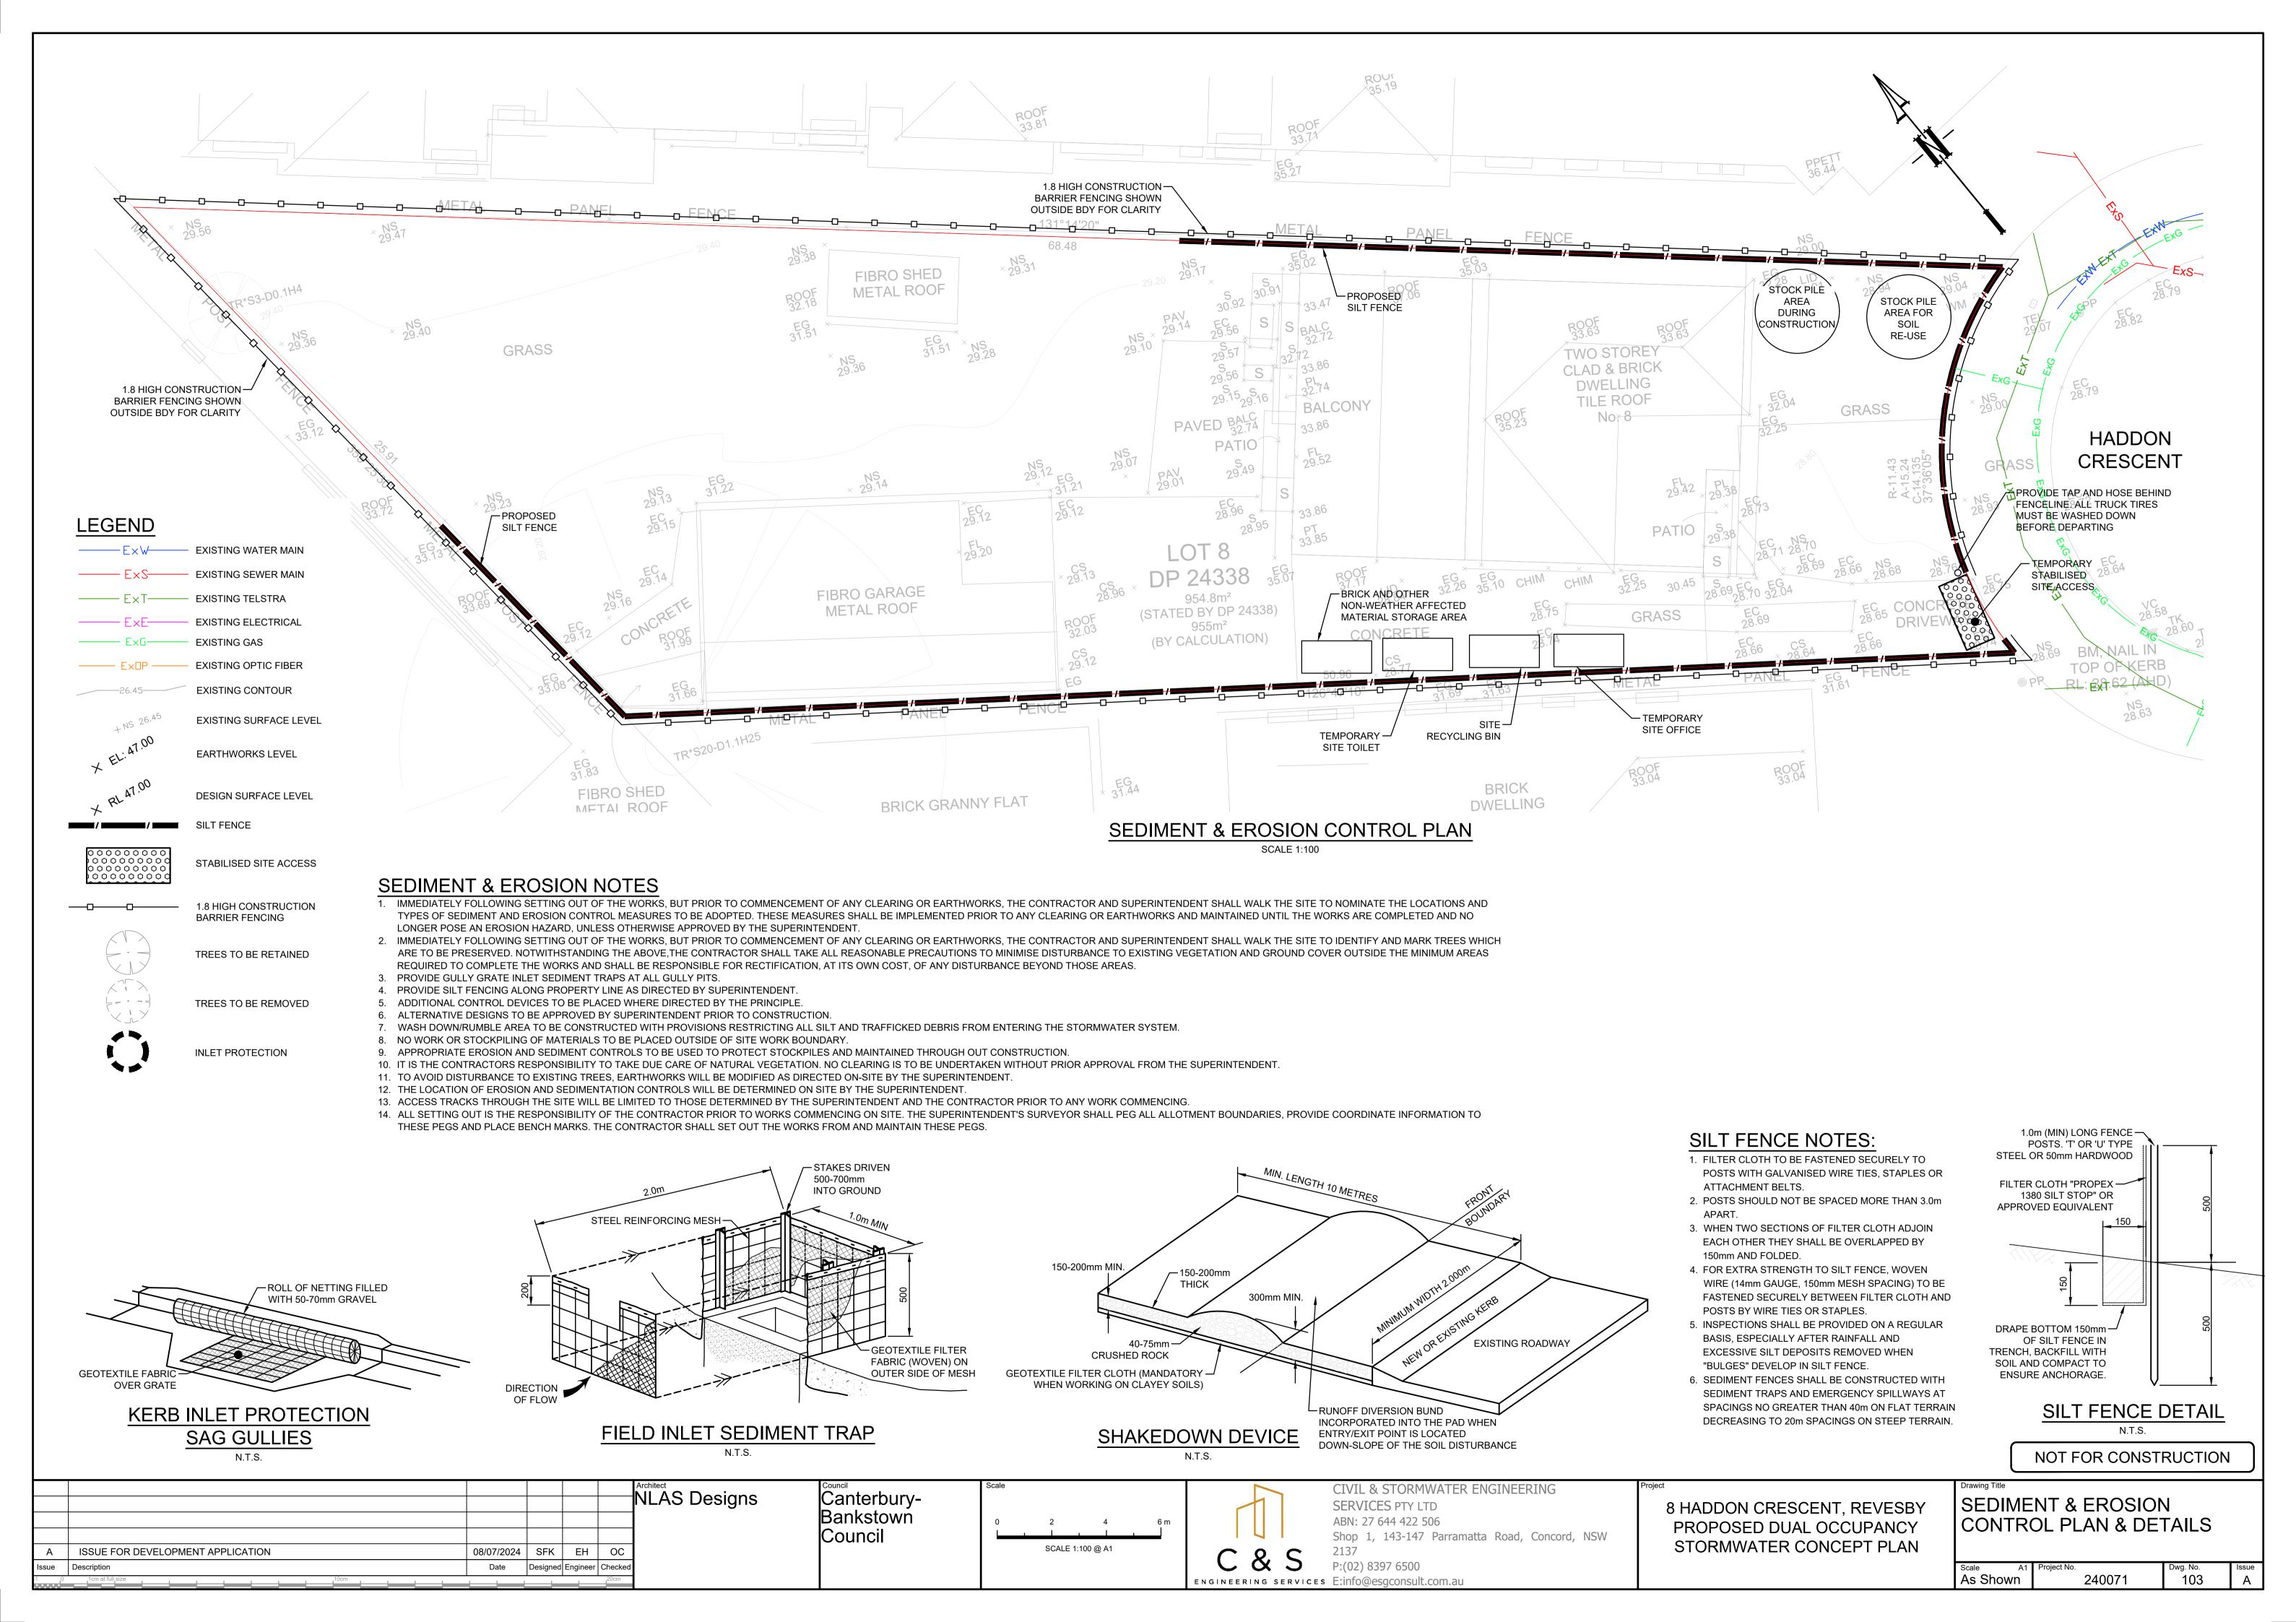

Stormwater Drainage System Maintenance Schedule							
Maintanana Astina	Durankous						
Maintenance Action General	Frequency	Responsibility	Procedure				
Inspect roof drainage system of building and remove any debris/sludge	Six Monthly	Strata/Maintenance Contractor	Remove any leaves or debris and sludge from gutters of building and flush downpipes of building to remove any blockages. Pits downstream of downpipes to be cleaned of flushed debris.				
Inspect pits and trench drains on site and remove debris/litter/sludge	Monthly or following Rain Period	Strata/Maintenance Contractor	Remove grate. Remove any debris/litter/sludge from within pits.				
Inspect site for litter and floatable debris and remove	Fortnightly	Strata/Maintenance Contractor	Remove litter from site and sweep all driveway and pathways in order to remove leaves or sediments that may enter into the drainage system.				
Storage							
Inspect storage & remove any sediment/sludge in pit	Six monthly	Strata/Maintenance Contractor	Remove grate(s) and screen(s). Remove sediment/sludge build-up.				
Inspect internal walls of storage (and external, if appropriate) for cracks or spalling	Annually	Strata/Maintenance Contractor	Remove grate(s) to inspect internal walls. Repair as required. Clear vegetation from external walls if necessary and repair as required.				
Inspect & remove any debris/litter/mulch etc blocking grates	Six monthly	Strata/Maintenance Contractor	Remove blockages from grate(s) and check if storage is blocked.				
Inspect areas draining to the storage(s) & remove debris/mulch/litter etc likely to block screens/grates	Six monthly	Strata/Maintenance Contractor	Remove debris and floatable material likely to be carried to grates.				
Compare storage volume to volume approved. (Rectify if loss > 5%)	Annually	Strata/Maintenance Contractor	Compare actual storage available with Work-as Executed plans. If volume loss is greater than 5%, arrange for reconstruction to replace the volume lost. Council to be notified of the proposal.				
Inspect storages for subsidence near pits	Annually	Strata/Maintenance Contractor	Check along drainage lines and at pits for subsidence likely to indicate leakages.				

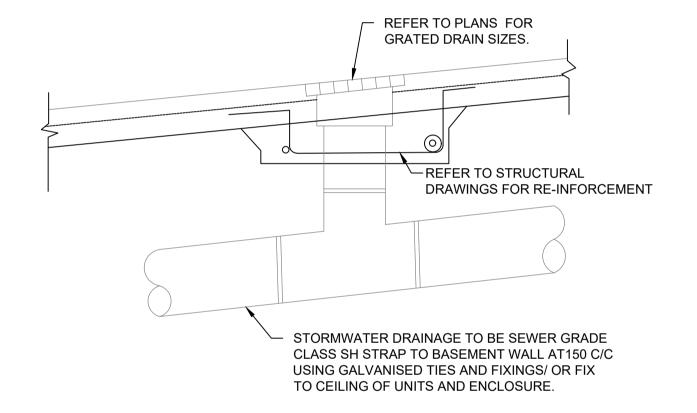

GRATED DRAIN DETAIL

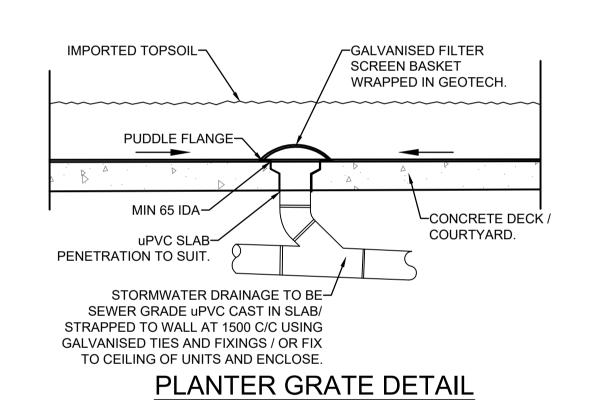

STORAGE TANK NOTES:

HUMAN CONSUMPTION".

SUPPLY AS BACKUP.

COUNCIL POLICY.

IRRIGATION USE.

METERS WHICHEVER IS LESS.

FROM ANY PROPERTY BOUNDARY.

DWELLING.

SYSTEM.

1. TANK WATER TAPS SHALL BE MARKED "RAINWATER NOT TO

2. RAINWATER TANKS SHALL BE CONNECTED TO MAINS WATER

3. THE PUMPS ARE TO BE INSULATED IN ACCORDANCE WITH

6. RAINWATER TANKS TO BE CLEANED OUT EVERY 6 MONTHS. 7. WATER TANK AND ASSOCIATED STRUCTURE TO BE THE SAME COLOR, OR A COLOR COMPLEMENTARY TO THE

8. TOP TANK TO BE BELOW TOP OF NEAREST FENCE, OR 1.8

9. THE WATER TANK SHOULD BE LOCATED AT LEAST 900mm

SEPARATED FROM THE RETICULATED WATER SUPPLY

13. ROOF DRAINING TO TANK MUST NOT CONTAIN LEAD, TAR


14. WATER TO BE DRAWN FROM ANAEROBIC ZONE OF TANK.


12.PROVIDE BACK-FLOW PREVENTION DEVICE AT MAINS WATER


10. PLUMBING FROM THE WATER TANK IS TO BE KEPT


11. TANK TO BE BUILT ON SELF-SUPPORTING BASE.


4. PUMPS SHALL PROVIDE MINIMUM 150 kPa PRESSURE. 5. EACH TANK TO BE CONNECTED TO AN OUTDOOR TAP FOR

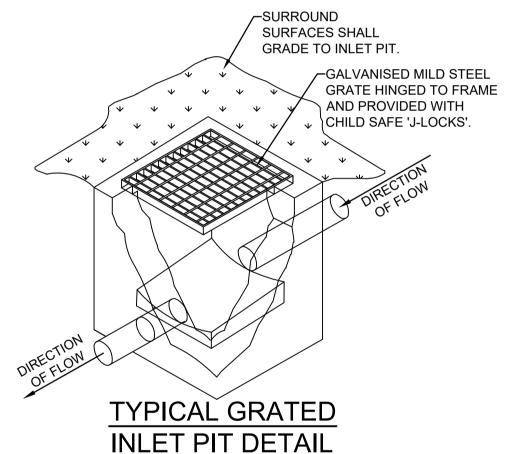

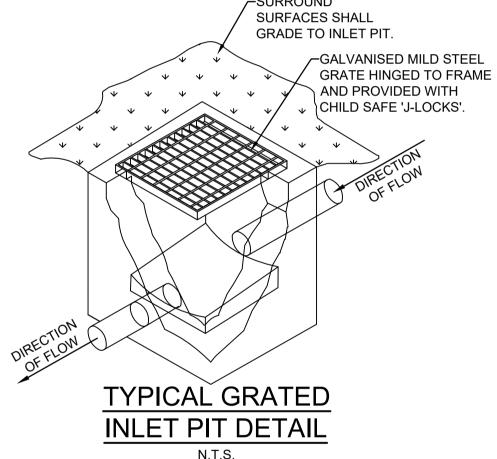

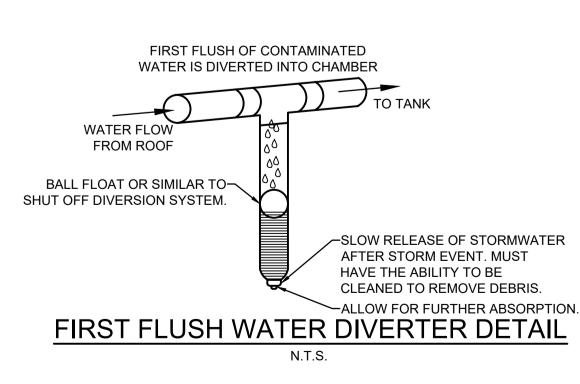

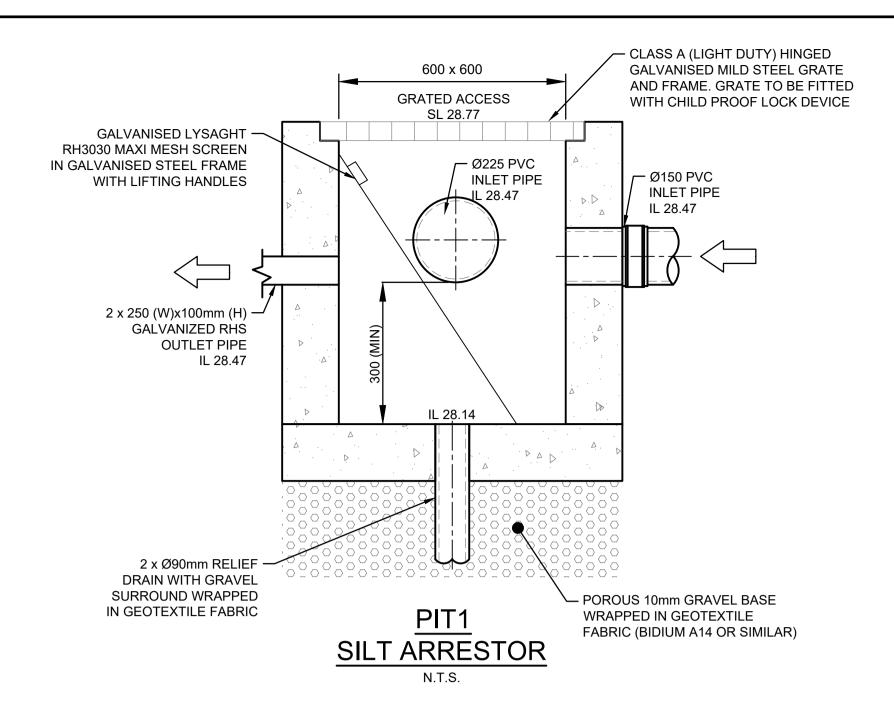

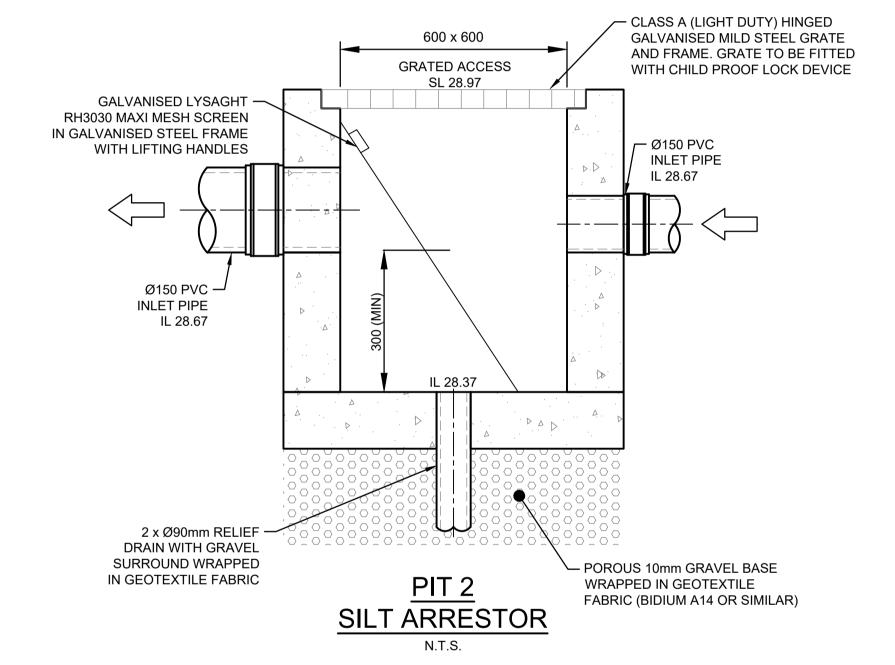



FIRST FLUSH OF CONTAMINATED WATER IS DIVERTED INTO CHAMBER
TO TANK
WATER FLOW FROM ROOF δ ⁰ δ ⁰
BALL FLOAT OR SIMILAR TO————————————————————————————————————
SLOW RELEASE OF STORMWATER AFTER STORM EVENT. MUST HAVE THE ABILITY TO BE CLEANED TO REMOVE DEBRIS.
FIRST FLUSH WATER DIVERTER DETAIL
N.T.S.

NOT FOR CONSTRUCTION

						NLAS Designs
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В	ISSUE FOR DEVELOPMENT APPLICATION	24/07/2024	SFK	EH	ОС	
Α	ISSUE FOR DEVELOPMENT APPLICATION	08/07/2024	SFK	EH	ОС	
Issue	Description	Date	Designed	Engineer	Checked	
1 0	1cm at full,size	1 1		-	,20cm	

Canterbury-Bankstown Council

BASED PAINTS OR ASBESTOS.

SCALE 1:100 @ A1

& S ENGINEERING SERVICES E:info@esgconsult.com.au

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8 HADDON CRESCENT, REVESBY PROPOSED DUAL OCCUPANCY STORMWATER CONCEPT PLAN

MAINTENANCE SCHEDULE & MISCELLANEOUS DETAILS SHEET

N.T.S. 104 240071